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# CHIEF PLENTY COUPS HOUSE AND STORE **RE-BID**

CHIEF PLENTY COUPS STATE PARK PRYOR, MONTANA AUGUST 24, 2022 100% CONSTRUCTION DOCUMENTS FWP PROJECT NUMBER: 7196121HS



OWNER: MONTANA FISH, WILDLIFE & PARKS SITE CONTACT: AARON KIND EMAIL: AKind@mt.gov



PHONE: (406) 252-1289 PRIMARY CONTACT: RANDI ROGNLIE, PROJECT MANAGER, DESIGN & CONSTRUCTION SECTION

EMAIL: Randi.Rognlie@mt.gov


PHONE: (406) 594-4322

PHONE: (406) 841-4019 MONTANA FISH, WILDLIFE AND PARKS HERITAGE PROGRAM SPECIALIST: BRENNA MOLONEY EMAIL: brennamoloney@mt.gov

NPS CONTRACTING OFFICER'S REPRESENTATIVE: THOMAS KEOHAN, HISTORICAL ARCHITECT PHONE: (303) 969-2897

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## UNITED DEPARTMENT


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STATE MAP M	PRYOR ONTANA FROM 1993 DRAWINGS	5			
<ul> <li>PECIAL REQUIREMENTS</li> <li>COORDINATE ALL WORK WITH FWP HERITAGE RESOURCE PROGRAM ARCHEOLOGIST. ALL SOIL WORK SHALL BE MONITORED WITH ARCHEOLOGIST. IF CONTRACTOR DISCOVERS ANY ARTIFACTS OR HUMAN REMAINS, CONTRACTOR SHALL IMMEDIATELY STOP WORK &amp; CONTACT THE ARCHEOLOGIST. CONTACT BRENNA MOLONEY, FWP HERITAGE RESOURCE SPECIALIST (SEE SHEET 1).</li> <li>ANY CHANGE, ALTERATION OR AMENDMENT TO THE WORK SPECIFIED IN THESE DOCUMENTS REQUIRES REVIEW AND APPROVAL BY THE FWP AND NATIONAL PARK SERVICE.</li> <li>REMOVE &amp; REINSTALL DOWNSPOUTS AS REQ'D TO DO THE WORK.</li> </ul>					
<ol> <li>SECRETARY OF INTERIOR'S STANDA</li> <li>COPIES OF DRAWINGS HAVE BEEN E AS NOTED.</li> <li>GROUND PENETRATING RADAR ANA 2018. THE RESULTANT REPORT HAS INCLUDED IN THE PROJECT MANUAL</li> <li>THIS PROJECT IS FUNDED BY THE N.</li> <li>COORDINATE ALL WORK WITH THE F</li> <li>ON NOVEMBER 2, 2018 CTA DOCUME CONDITION. THIS INFORMATION HAS FOR FUTURE MONITORING EFFORTS</li> <li>THIS PROJECT'S SCOPE OF WORK IN MINIMAL EAVE/GUTTER WORK, ROOF NEEDED) WINDOW REPLACEMENT, &amp;</li> <li>CONTRACTOR SHALL PROTECT EXIS RUN OVER THE LAWN WITHOUT PRO WEIGHT &amp; PROTECT THE VEGETATION ACTIVITY WITH FWP PRIOR TO THE A</li> <li>THIS BUILDING WILL NOT BE OCCUPI</li> <li>THE CONTRACTOR SHALL COORDIN. UNINTERRUPTED CONSTRUCTION.</li> <li>THE CONTRACTOR SHALL PROTECT</li> <li>ALL WORK UNDER THIS CONTRACT S REGULATIONS INCLUDING BUT NOT FWP GUIDELINES, &amp; SECERATARY O</li> <li>DO NOT SCALE THE DRAWINGS. VER FURTHER CLARIFICATION IF NEEDED</li> <li>THE CONTRACTOR &amp; ALL SUB-CONT START OF CONSTRUCTION. NOTIFY D DISCREPANCIES IN THE DRAWINGS OF AS REQUIRED FOR THE WORK.</li> <li>ALL WORK SHALL BE PERFORMED IN THE CONTRACTOR SHALL PROVIDE ADJACENT AREAS OF THE BUILDING ISCREPANCIES IN THE DRAWINGS OF ADJACENT AREAS OF THE BUILDING</li> </ol>	ATIONAL PARK SERVICE'S SAVE AMERICA'S TREASURES WP HERITAGE RESOURCE PROGRAM ARCHEOLOGIST. INTED MOISTURE CONTENT OF SILL LOGS & LOGS IN VIS INFORMED THE SCOPE OF WORK AND WILL BE SUBMIT S. ACLUDES FOUNDATION REPAIRS & STABILIZATION, REGF REPAIRS AND REPLACEMENT, LOG REPAIR AND REPLA CHINKING/ DAUBING. TING SOILS & VEGETATION. NO VEHICLES OR EQUIPMEN VIDING SHEETS OF PLYWOOD UNDERNEATH TO DISTRIE ON. CONTRACTOR SHALL REVIEW ANY SUCH OVER-THE- ACTIVITY. NO VEHICLE PARKING ON THE LAWN. IED DURING THE CONSTRUCTION PERIOD. ATE ALL WORK PERFORMED BY OTHERS TO ENSURE SM ALL SURFACES & ITEMS TO REMAIN. SHALL COMPLY WITH ALL APPLICABLE CODES, ORDINAN LIMITED TO THE 2021 INTERNATIONAL EXISTING BUILDIN F THE INTERIORS STANDARDS.	S. CHITECTURE, OVEMBER 2, AND WILL BE PROGRAM. BIBLY POOR TED TO FWP RADING, ACEMENT (AS NT SHALL BE BUTE THE LAWN MOOTH ICES, & IG CODE, ALL ITECT FOR OR TO THE IONS. NEW DETAILS ZARD. BLIC & WORK.			
ARCHITECTURAL AND HISTORIC SIGNIFICA MATERIAL, AND AESTHETIC VALUE. THE W ADMINISTERED BY THE NATIONAL PARK S	B DESIGNATED A NATIONAL HISTORIC LANDMARK FOR IT ANCE. IT IS CONSIDERED TO HAVE IRREPLACEABLE CUL ORK IS FUNDED IN PART BY THE HISTORIC PRESERVATI ERVICE, DEPARTMENT OF THE INTERIOR. THE FUNDING ET THE SECRETARY OF THE INTERIOR'S STANDARDS FO	TURAL, ON FUND, OF WHICH IS			
STABILIZATION	TITLE OF PROJECT	DRAWING NO.			
UNITED STATES DEPARTMENT OF THE INTERIOR	LOCATION WITHIN PARK CHIEF PLENTY COUPS HOUSE	PKG. SHEET			
NATIONAL PARK SERVICE ERITAGE PARTNERSHIPS PROGRAM	NAME OF PARK CHIEF PLENTY COUPS <u>REGION COUNTY</u> <u>STATE</u> BIG HORN MT	INC. [1] OF <u>8</u>			

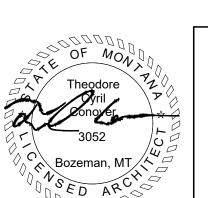

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∎ SC	ALE: 1	/4" = 1'-0	" NO	RTH REF

- 1. SEE GENERAL PROJECT NOTES ON COVER SHEET.
- 3. SENSITIVE CULTURAL RESOURCES ARE KNOWN TO BE PRESENT. DO NOT DISTURB AND ALERT MONITORING ARCHEOLOGIST IF ANY ARTIFACTS OR OTHER CULTURAL ITEMS
- 4. TRIBAL AND HERITAGE ARCHAEOLOGISTS TO BE ON-SITE DURING ALL GROUND
- 6. FLAG SPRINKLER SYSTEM LINES AND HEADS PRIOR TO ANY WORK TO AVOID


- STABILIZE AND REPAIR EXISTING SUB-GRADE FOUNDATION WALL. GROUND  $\langle 1 \rangle$  PENETRATING RADAR EVIDENCE SHOWS THAT EXISTING FOUNDATION WALL HAS
- $\langle 3 \rangle$  TEMPORARILY SHORE PORCH ROOF TO ALLOW FOR SPEC'D REPAIRS.
- (4) REMOVE EXISTING CONCRETE PIER & STONE CAP. SALVAGE STONE FOR REUSE. PROVIDE NEW CONCRETE PIER & REINSTALL STONE CAP.
- REPLACE BOTTOM 3 1/2" OF EXISTING PORCH POST, MOUNTING BOTTOM PORTION  $\frac{1}{2}$ " 
   5
   MIN. ABOVE FLOOR BOARD. DETAIL PER 7/A7. PAINT FULL HEIGHT OF POST TO MATCH
- REMOVE EXISTING WOOD PLANK FLOOR BOARDS & REINSTALL WITH MATCHING (SAME  $\langle 6 \rangle$  THICKNESS & WIDTH, ROUGH SAWN 1 x 8), INSTALLED RUNNING N/S, MATCHING
- REMOVE FULL LENGTH OF EXISTING 2x FLOOR DECK FASCIA & CONFIRM CONDITION OF  $\overline{7}$  2x RIM JOIST. ALLOW TIME FOR ARCHITECT TO REVIEW. PROVIDE 2x DECK FASCIA.
- PROVIDE PRESSURE TREATED WOOD BLOCK SUPPORT BELOW FLOORING BELOW <sup>8</sup> PROVIDE PRESSURE TREATED WOOD BLOCK OUT ON ELECTION E
- FOR FULL LENGTH OF PORCH, REMOVE LOOSE LEAVES & VEGETATION. REMOVE RAISED GRADE BY HAND. CONSTRUCT NEW FINISHED GRADE BY HAND, AWAY FROM (9) DECK FASCIA AT 5% SLOPE. NEW FINISHED GRADE SHALL NOT CAUSE ANY STORM PONDING OR EROSION CHANNELS. COORDINATE WITH TRIBAL AND HERITAGE
- (10) REMOVE EXISTING WIRE SCREENING BETWEEN STONE PIERS OF PORCH (FULL LENGTH). PROVIDE WIRE SCREENING OF SMALLER GRID.
- REMOVE EXISTING GUTTER, LOWEST TWO ROOF DECK BOARDS, & ROOFING AS REQ'D TO ACCESS. PROVIDE LOWER DECK BOARDS, SELF-ADHERED MEMBRANE, & DRIP EDGE. PROVIDE MATCHING ROOF SHINGLES & RE-HANG EXISTING GUTTER AT LEAST 1" BELOW BOTTOMMOST ROOF/EAVE SHINGLE.
- (12) REMOVE EXISTING GUTTER & RE-MOUNT AT LEAST 1" BELOW BOTTOMMOST
- REMOVE RAISED GRADE BY HAND. CONSTRUCT NEW FINISHED GRADE BY HAND, AWAY FROM BUILDING AT 5% SLOPE FOR 10 FEET ON NORTH SIDE OF BUILDING AND 5% (13) SLOPE FOR 10 FEET ON WEST SIDE OF BUILDING. NEW FINISHED GRADES SHALL NOT CAUSE ANY STORM PONDING OR EROSION CHANNELS. COORDINATE WITH TRIBAL AND
- PROVIDE LONGER (BY 6'-0" +/-) EXTENSION TO DOWNSPOUT, TO KEEP RUN-OFF AWAY FROM HOUSE.
- (15) REMOVE EXISTING SILL LOG & PROVIDE REPLICA SILL LOG. TREAT WITH  $\frac{3}{4}$ " BORATE RODS @ 14" O.C.
- GRIND/SHAPE CONCRETE FROM FULL LENGTH OF GAP BETWEEN SILL LOG & STONE FOUNDATION TO SLOPE DOWN AWAY FROM LOG.
- REMOVE EXISTING PORCH BOARDS AND PREPARE FOR REINSTALLATION. ROTATE (19) BOARDS 90 DEGREES TO RUN PERPENDICULAR TO WALL PLANE AND INSTALL AS
- CAREFULLY REMOVE INTERIOR CHINKING. INSTALL NEW CHINKING TO MATCH EXISTING
- $\langle 21 \rangle$  TEMPORARILY SHORE STORE TO ALLOW FOR SPEC'D REPAIRS.
- REMOVE EXISTING HOLLOW CLAY TILE FOUNDATION. PROVIDE PRESSURE TREATED (22) WOOD BLOCKING SUPPORT BELOW SILL LOG. PROVIDE NEW CONCRETE PIERS BELOW BLOCKING. COORDINATION WITH OTHER WORK. (SEE PIER DETAIL.)
- (23) REMOVE EXISTING SILL LOG & PROVIDE REPLICA SILL LOG. TREAT WITH  $\frac{3}{4}$ " BORATE RODS @ 14" O.C.

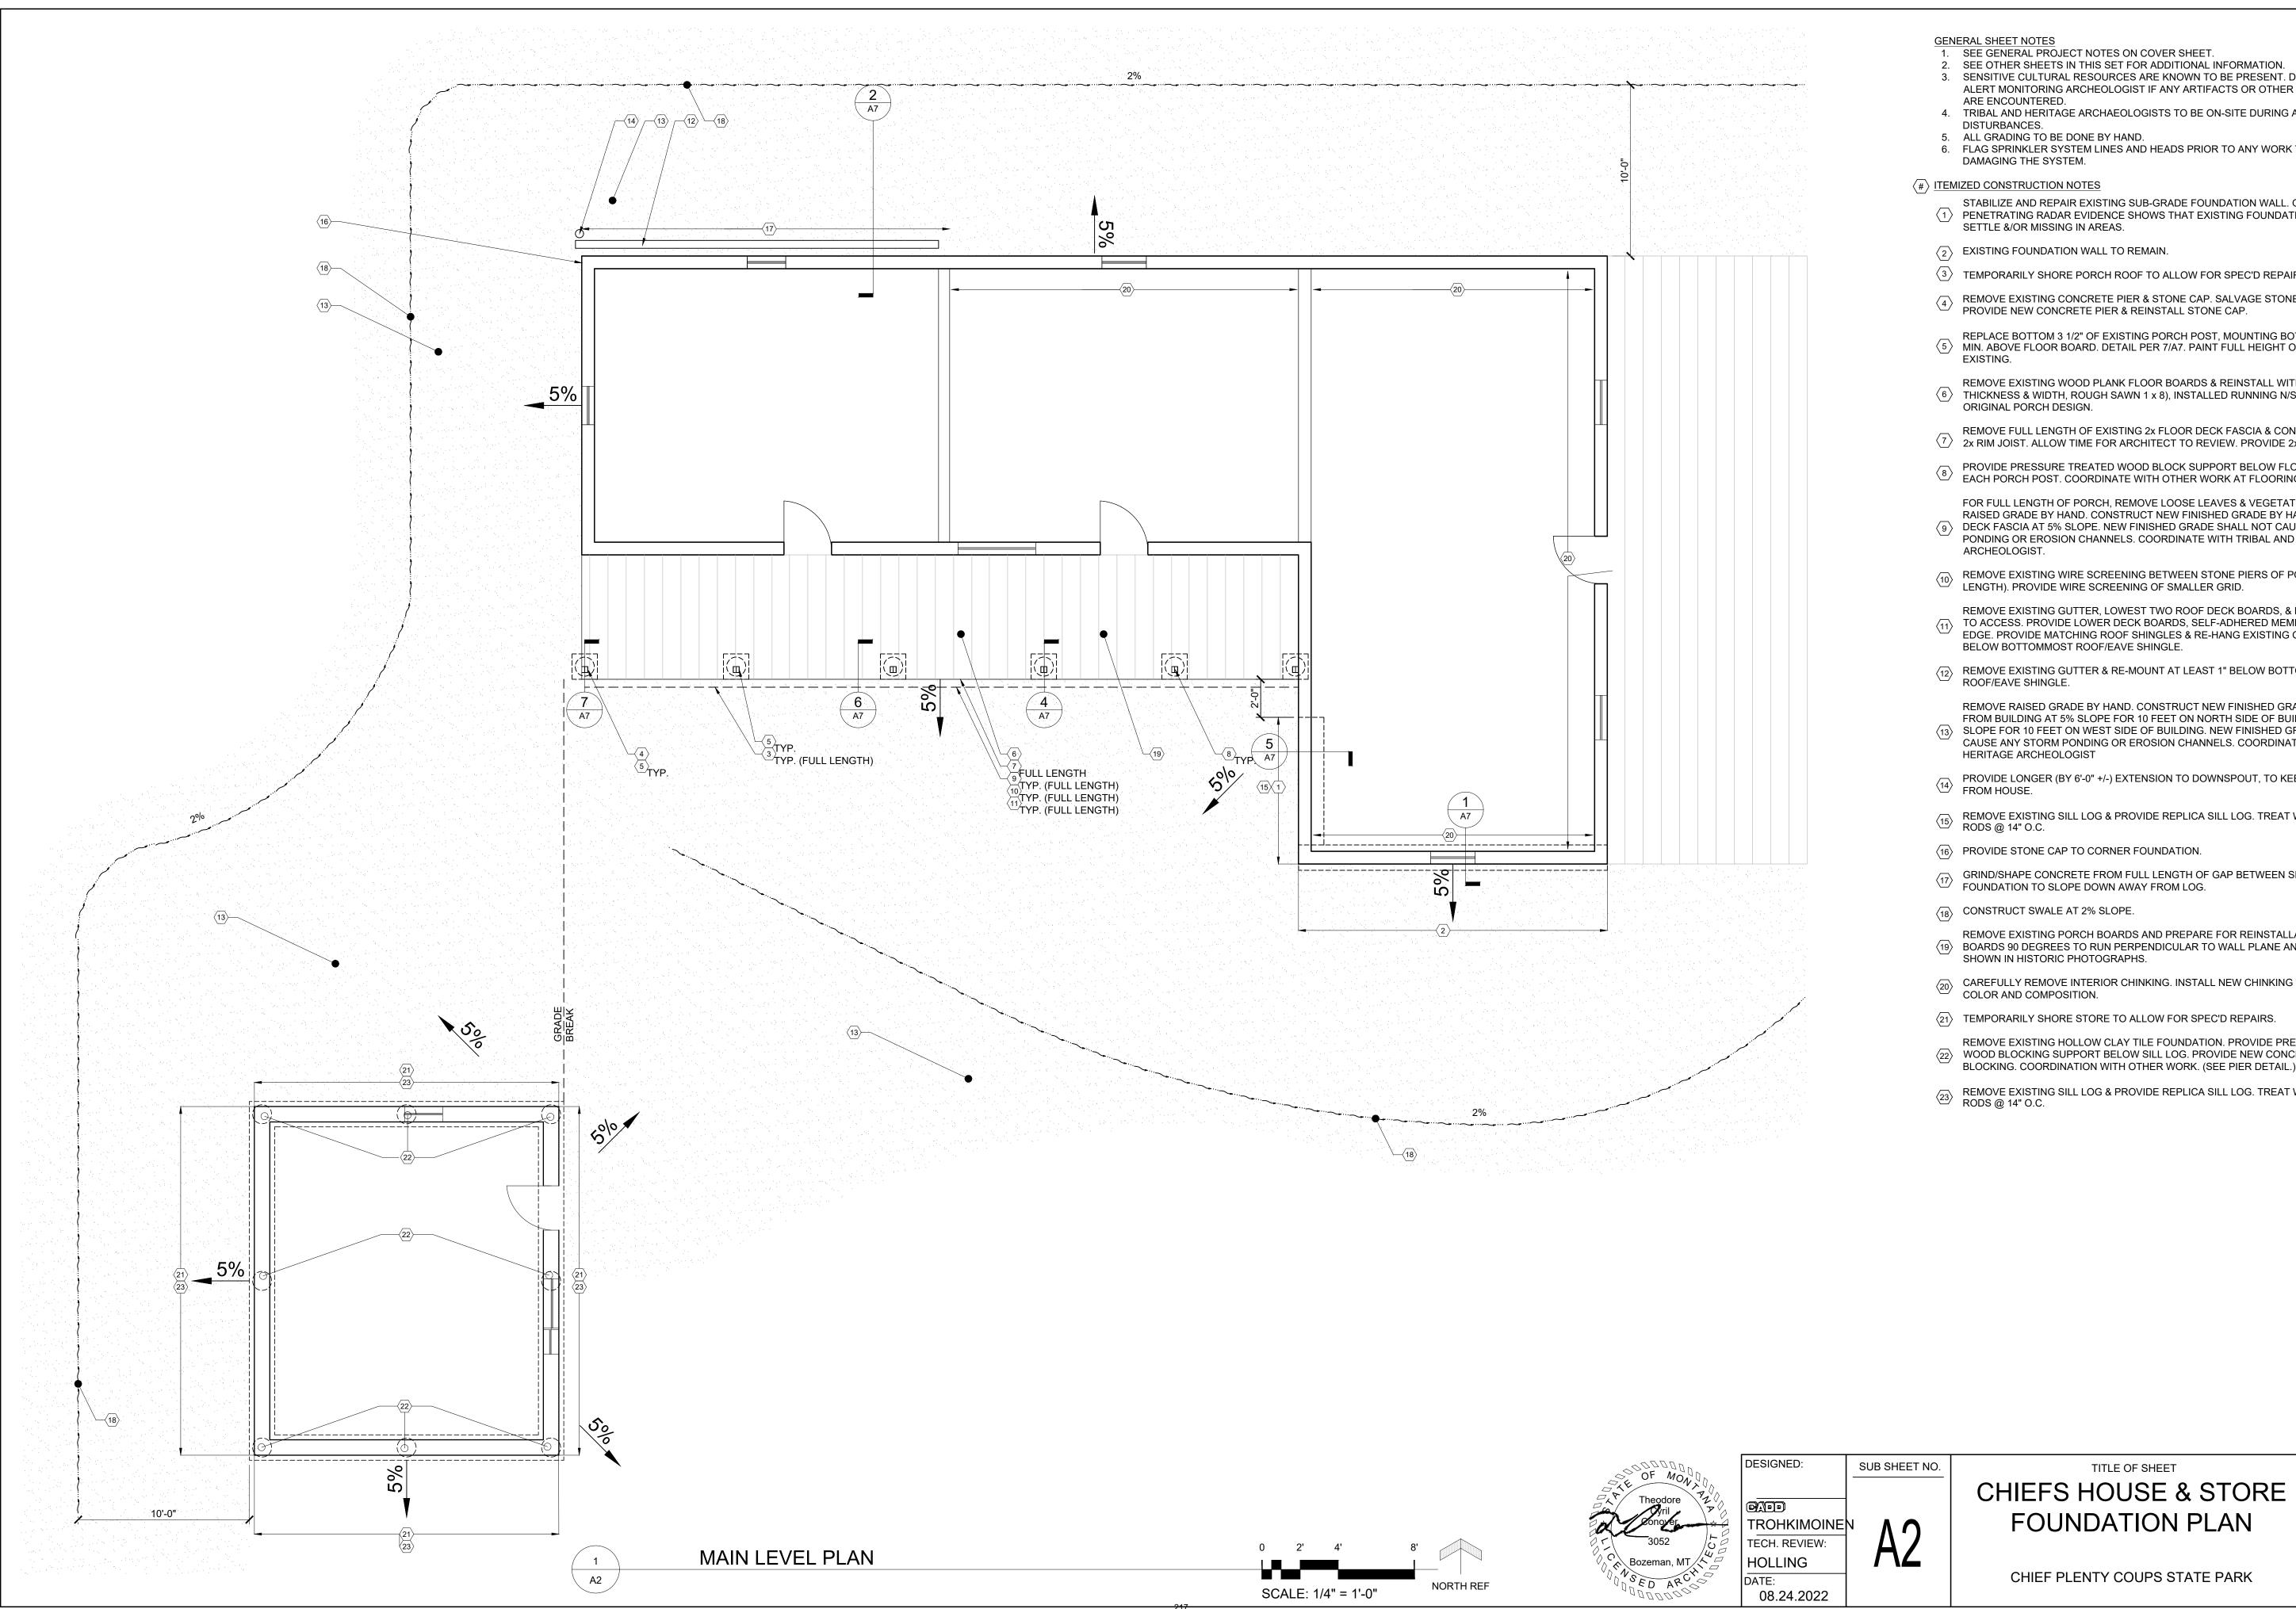DRAWING NO.

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CHIEF'S HOUSE DOWNSPOUT AT SOUTHWEST CORNER



10

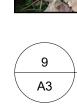A3








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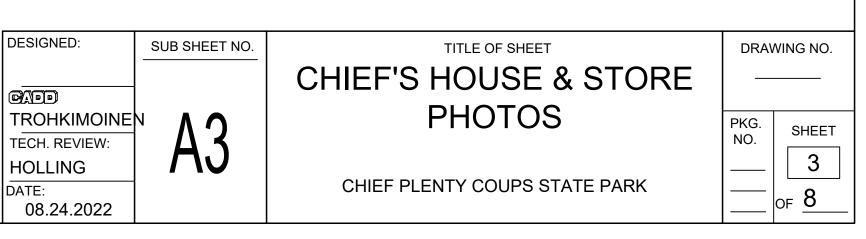
CHIEF'S HOUSE, EARTH SLOPING DOWN TOWARDS NORTH SIDE OF BUILDING


NORTHWEST CORNER, SHOWING EARTH SLOPING DOWN TOWARDS WEST SIDE ON BUILDINGS

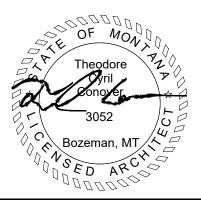


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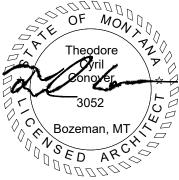
- <u>GENERAL SHEET NOTES</u>
  SEE GENERAL PROJECT NOTES ON COVER SHEET.
  SEE OTHER SHEETS IN THIS SET FOR ADDITIONAL INFORMATION.
  SENSITIVE CULTURAL RESOURCES ARE KNOWN TO BE PRESENT. DO NOT DISTURB AND ALERT MONITORING ARCHEOLOGIST IF ANY ARTIFACTS OR OTHER CHILDRAL ITEMS ARE ENCOUNTEDED.
- OTHER CULTURAL ITEMS ARE ENCOUNTERED. 4. TRIBAL AND HERITAGE ARCHAEOLOGISTS TO BE ON-SITE DURING ALL GROUND DISTURBANCES.
- ALL GRADING TO BE DONE BY HAND.
   FLAG SPRINKLER SYSTEM LINES AND HEADS PRIOR TO ANY WORK TO AVOID DAMAGING THE SYSTEM.





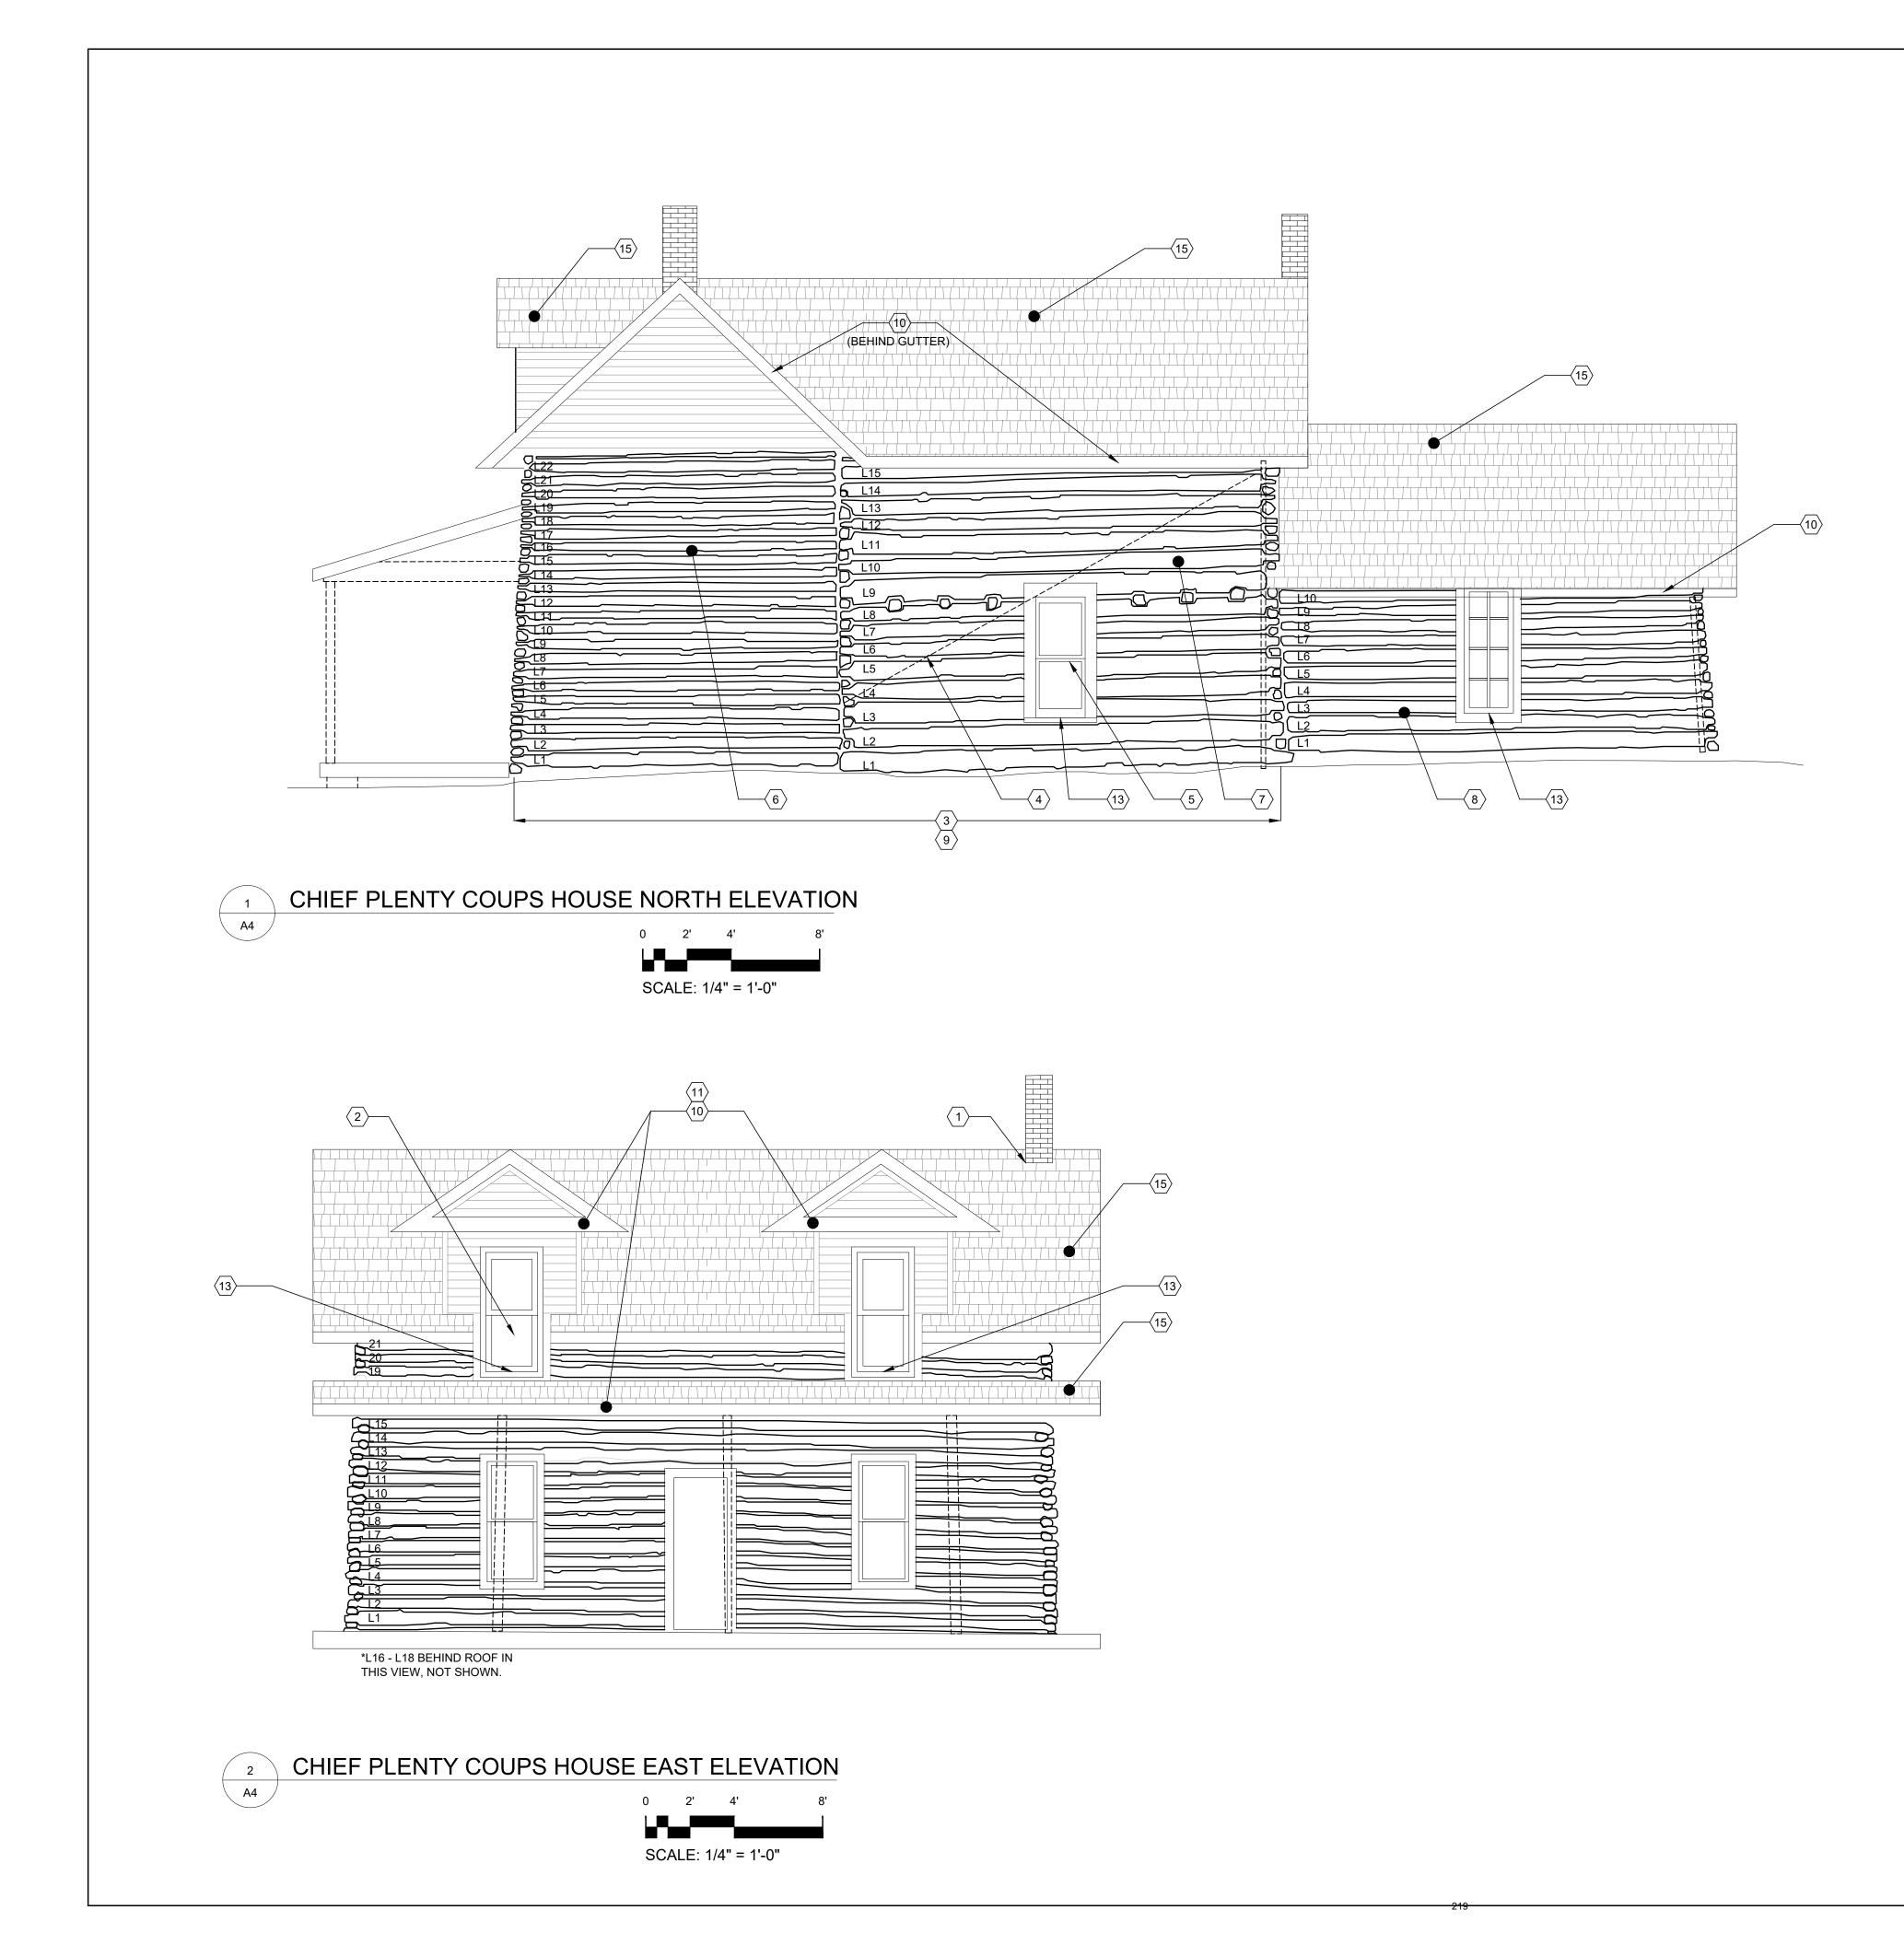

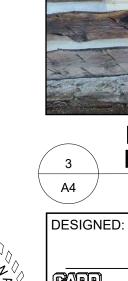




GENERAL ELEVATION NOTES

- 1. PROVIDE BACKER ROD AND SEALANT TO ALL JOINTS BETWEEN TOP OF LOG WALL AND SOFFIT BOARDS.
- 2. EXTERIOR LOGS SHOULD BE PRESERVED AND REHABILITATED IN ACCORDANCE WITH THE SECRETARY OF THE INTERIOR'S STANDARDS - PRESERVATION BRIEF 26: THE PRESERVATION AND REPAIR OF HISTORIC LOG BUILDINGS.
- 3. CLEAN EXTERIOR OF ALL LOGS WITH GENTLE CLEANER AND METHOD. CLEANER SHALL BE WATER AND TSP. DO NOT POWER WASH. RINSE THOROUGHLY WITH A GARDEN HOSE SPRAYER. NEW LOGS SHALL BE OF SAME LOG SPECIES AND SIZE AS EXISTING LOGS OR EQUIVALENT LOG SPECIES ON EXISTING STRUCTURE WITH MATCHING STAIN.
- 4. ALL NEW EXTERIOR WINDOW AND DOOR TRIM SHALL MATCH EXISTING IN SIZE, DIMENSION, PROFILE, AND FINISH. PROVIDE BACKERROD (SIZED ACCORDINGLY) AND URETHANE SEALANT BETWEEN REINSTALLED TRIM AND LOG.
- 5. REPLACEMENT LOGS TO MATCH EXISTING LOG PROFILES CRITICAL. CONTRACTOR SHALL EXAMINE THE STRUCTURE TO DETERMINE THE CHARACTER OF THE MATERIALS TO BE REMOVED AND REPLACED IN-KIND AND
- THE NATURE OF THE WORK IN GENERAL. 6. ALL LOGS, NOTCHING, REPLACEMENT AND RECONSTRUCTION WORK SHALL MATCH IN-KIND WITH ADJACENT HISTORIC CONDITIONS.
- 7. IN ADDITION TO CHINKING REQ'D AT LOG REPLACEMENTS, CONTRACTOR SHALL RECHINK ALL LOG JOINTS, U.N.O..
- 8. APPLY UV FILM ON INTERIOR OF ALL WINDOWS (SEE SPECS).

(#)TEMIZED CONSTRUCTION NOTES

- $\langle 1 \rangle$  SECURE FLASHING
- (2) CAREFULLY REMOVE AND REPLACE GLASS TO MATCH EXISTING.
- (3) WILLOW DETERIORATION FULL LENGTH AT EACH LOG. CAREFULLY REMOVE AND REPLACE IN KIND.
- 4 EXISTING METAL ROD THROUGH LOGS FOR SUPPORT. BEING CAREFUL NOT TO REMOVE ROD WHEN PATCHING/REPAIRING LOGS OR WINDOW.
- WINDOW RAIL DETERIORATED. CAREFULLY REMOVE WINDOW AND REBUILD  $\langle 5 \rangle$  SASH AND RAIL IN-KIND. FURTHER EXAMINE EXTENT OF POWER POST BEETLE DAMAGE TO SEE IF MORE THAN THE SASH AND RAIL NEEDS REPLACED. (SEE PHOTO 1)
- LOG FACE APPEARS TO BE SHOWING SIGNS OF DETERIORATION. REPLACE MINIMUM OF 10 LINEAR FEET, IN TOTAL, FOR LOG FACES ON 14 AND 19. LOOK 6 MINIMUM OF 10 LINEAR FEET, IN TOTAL, FOR LOST AGES STATEMENTS FOR FULL DETERIORATION EXTENT. PATCH/REPAIR AS NECESSARY AND SHALL MATCH EXISTING PROFILES.
- LOG 10 IS SHOWING SIGNS OF CONTINUOUS SEPARATION ACROSS FULL  $\langle 7 \rangle$  LENGTH (APPROXIMATELY 20 LINEAR FEET). REPLACEMENT MAY BE REQUIRED. LOOK FOR FULL DETERIORATION EXTENT. PATCH/REPAIR AS NECESSARY AND SHALL MATCH EXISTING PROFILES.
- LOGS 1 AND 4 ARE SHOWING SIGNS OF LOG FACE SEPARATION (APPROXIMATELY 30 LINEAR FEET, IN TOTAL). LOG FACE REPLACEMENT MAY BE REQUIRED. LOOK FOR FULL DETERIORATION EXTENT. PATCH/REPAIR AS NECESSARY AND SHALL MATCH EXISTING PROFILES.
- 9 CAREFULLY REMOVE EXTERIOR CHINKING, FULL LENGTH AT EACH LOG. CHINKING TO MATCH EXISTING COLOR AND COMPOSITION.
- FASCIA BOARD DETERIORATION ALONG ENTIRE LENGTH OF BUILDING. (10) CAREFULLY REMOVE FASCIA BOARD(S) AND REPLACE WITH IN-KIND FASTENING METHODS, FASTENING TYPES, PAINT, ETC.
- RAKE BOARD DETERIORATION ALONG LENGTH OF BUILDING, INCLUDING (1) DORMERS. CAREFULLY REMOVE RAKE BOARD(S) AS REQUIRED AND REPLACE WITH IN-KIND FASTENING METHODS, FASTENING TYPES, PAINT, ETC.
- (12) NOT USED.
- WINDOW SILL DETERIORATION. CAREFULLY REMOVE WINDOW SILL AS (13) REQUIRED AND REPLACE WITH IN-KIND FASTENING METHODS, FASTENING TYPES, PAINT, ETC. (SEE PHOTO 4)
- (14) NOT USED.
- FULL IN-KIND FIRE RETARDANT CEDAR SHINGLE ROOF REPLACEMENT. REMOVE EXISTING CEDAR SHINGLES DOWN TO UNDERLAYMENT. EXAMINE AND REPLACE ANY DAMAGED AND DETERIORATED UNDERLAYMENT AS REQ'D PRIOR TO NEW SHINGLE INSTALLATION.

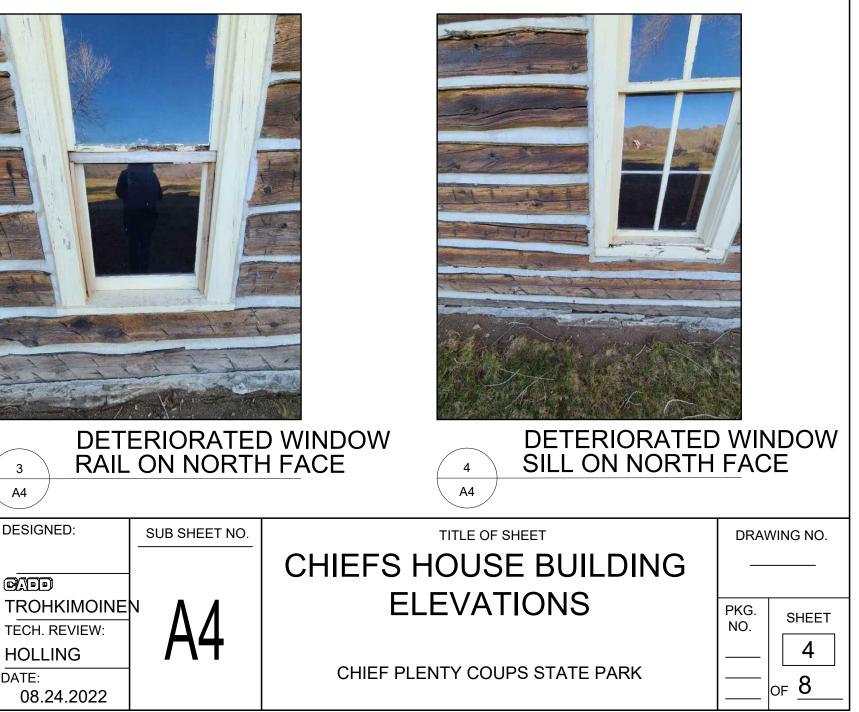



- 1. PROVIDE BACKER ROD AND SEALANT TO ALL JOINTS BETWEEN TOP OF LOG
- WITH THE DEPARTMENT OF SECRETARY STANDARDS PRESERVATION BRIEF
- 3. CLEAN EXTERIOR OF ALL LOGS WITH GENTLE CLEANER AND METHOD. CLEANER SHALL BE WATER AND TSP. DO NOT POWER WASH. RINSE THOROUGHLY WITH A GARDEN HOSE SPRAYER. NEW LOGS SHALL BE OF SAME LOG SPECIES AND SIZE AS EXISTING LOGS OR EQUIVALENT LOG SPECIES ON EXISTING
- 4. ALL NEW EXTERIOR WINDOW AND DOOR TRIM SHALL MATCH EXISTING IN SIZE, DIMENSION, AND PROFILE. PROVIDE BACKERROD (SIZED ACCORDINGLY) AND CONTRACTOR SHALL EXAMINE THE STRUCTURE TO DETERMINE THE CHARACTER OF THE MATERIALS TO BE REMOVED AND REPLACED WITH IN-KIND FASTENING METHODS, FASTENING TYPES, FINISHES, ETC, AND THE NATURE OF

- - APPROXIMATELY 52 LINEAR FEET, TOTAL. REPLACEMENT OF LOG FACE OR  $\langle 1 \rangle$  ENTIRE LOG MAY BE REQUIRED. LOOK FOR FULL DETERIORATION EXTENT. PATCH/REPAIR AS NECESSARY AND SHALL MATCH EXISTING PROFILES.

LOG FACE APPEARS TO BE SHOWING SIGNS OF DETERIORATION. REPLACE MINIMUM OF 20 LINEAR FEET, IN TOTAL, FOR LOG FACES ON LOGS 2 (ON THE  $\langle 2 \rangle$  SOUTH ELEVATION) AND 2 AND 3 (L1 AND L4 ENDS) (ON THE WEST ELEVATION). LOOK FOR FULL DETERIORATION EXTENT. PATCH/REPAIR AS NECESSARY AND


- CAREFULLY REMOVE EXTERIOR CHINKING ON WEST ELEVATION. CHINKING TO  $\langle 4 \rangle$  MATCH EXISTING COLOR AND COMPOSITION. APPLIES TO ENTIRE FACE UNO.
- CAREFULLY REMOVE EXTERIOR CHINKING AT SHADED AREA ON WEST  $\langle 5 \rangle$  ELEVATION . CHINKING TO MATCH EXISTING COLOR AND COMPOSITION. (SEE
- <sup>6</sup> RE-CHINK LOGS 1 8 ON WEST ELEVATION. CHINKING TO MATCH EXISTING COLOR AND COMPOSITION.

- (10) WILLOW BRANCH STABILIZER DETERIORATION, APPROXIMATELY 5 LINEAR FEET. CAREFULLY REMOVE AND REPLACE IN KIND. (SEE PHOTO 3)
- $\langle 11 
  angle$  REMOVE FASCIA BOARD(S) AS REQUIRED AND REPLACE WITH IN-KIND


- $\langle 14 \rangle$  REQUIRED AND WITH IN-KIND FASTENING METHODS, FASTENING TYPES, PAINT,
- FULL IN-KIND FIRE RETARDANT CEDAR SHINGLE ROOF REPLACEMENT. REMOVE 16 EXISTING CEDAR SHINGLES DOWN TO UNDERLAYMENT. EXAMINE AND REPLACE ANY DAMAGED AND DETERIORATED UNDERLAYMENT AS REQ'D PRIOR TO NEW



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0	2'	4'	8'
SC	ALE: 1	1/4" = 1'-	0"

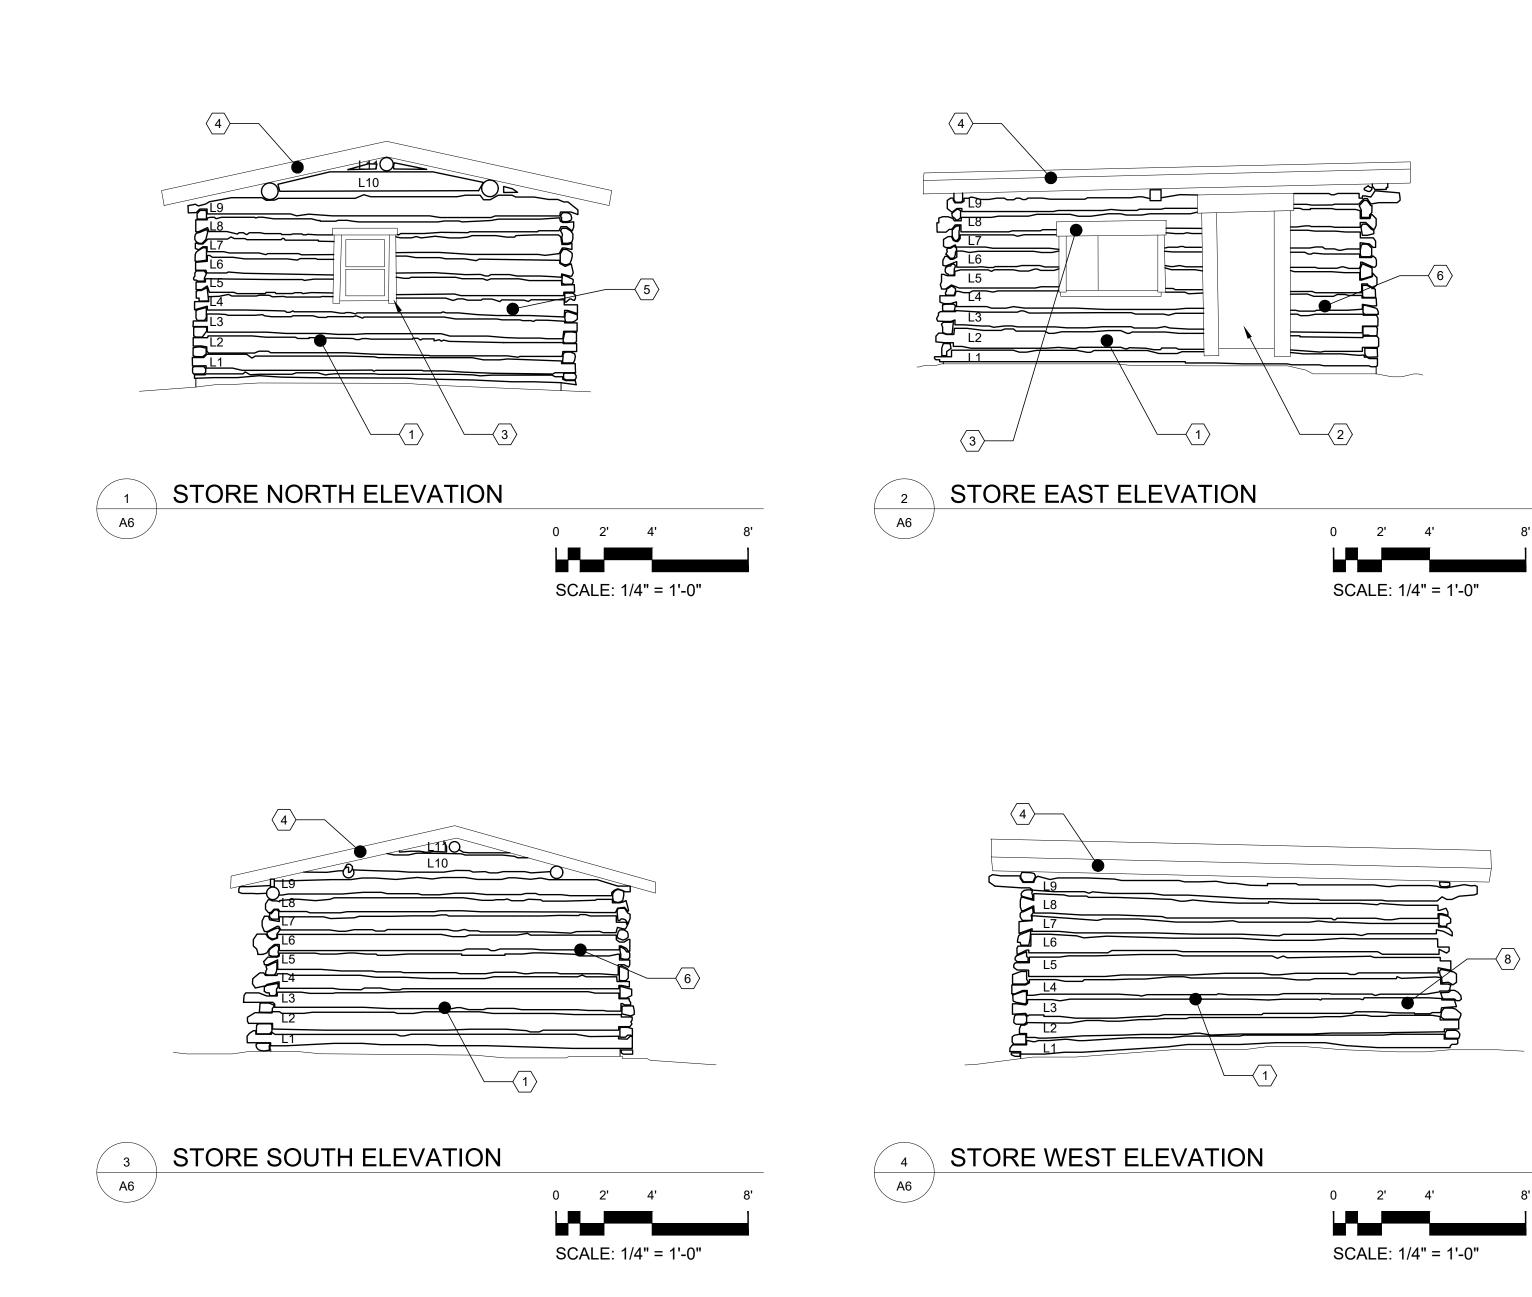

GENERAL ELEVATION NOTES

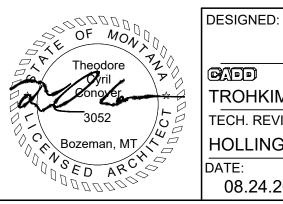- 1. PROVIDE BACKER ROD AND SEALANT TO ALL JOINTS BETWEEN TOP OF LOG WALL AND SOFFIT BOARDS.
- 2. EXTERIOR LOGS SHOULD BE PRESERVED AND REHABILITATED IN ACCORDANCE WITH THE DEPARTMENT OF SECRETARY STANDARDS - PRESERVATION BRIEF 26: THE PRESERVATION AND REPAIR OF HISTORIC LOG BUILDINGS.
- 3. CLEAN EXTERIOR OF ALL LOGS WITH GENTLE CLEANER AND METHOD. CLEANER SHALL BE WATER AND TSP. DO NOT POWER WASH. RINSE THOROUGHLY WITH A GARDEN HOSE SPRAYER. NEW LOGS SHALL BE OF SAME LOG SPECIES AND SIZE AS EXISTING LOGS OR EQUIVALENT LOG SPECIES ON EXISTING STRUCTURE WITH MATCHING STAIN.
- 4. ALL NEW EXTERIOR WINDOW AND DOOR TRIM SHALL MATCH EXISTING IN SIZE, DIMENSION, AND PROFILE. PROVIDE BACKERROD (SIZED ACCORDINGLY) AND URETHANE SEALANT BETWEEN REINSTALLED TRIM AND LOG.
- 5. REPLACEMENT LOGS TO MATCH EXISTING LOG PROFILES CRITICAL. CONTRACTOR SHALL EXAMINE THE STRUCTURE TO DETERMINE THE CHARACTER OF THE MATERIALS TO BE REMOVED AND REPLACED IN-KIND AND THE NATURE OF THE WORK IN GENERAL.
- 6. ALL LOGS, NOTCHING, REPLACEMENT AND RECONSTRUCTION WORK SHALL MATCH IN-KIND WITH ADJACENT HISTORIC CONDITIONS.
- 7. IN ADDITION TO CHINKING REQ'D AT LOG REPLACEMENTS, CONTRACTOR SHALL RECHINK ALL LOG JOINTS, U.N.O..

(#)<u>ITEMIZED CONSTRUCTION NOTES</u>

- CAREFULLY REMOVE EXTERIOR CHINKING, FULL LENGTH ON ALL SIDES, AT (1) EACH LOG. CHINKING TO MATCH EXISTING COLOR AND COMPOSITION. APPLIES TO ENTIRE FACE UNO.
- $\langle 2 \rangle$  REMOVE AND REBUILD DOOR.
- 3 REMOVE AND REPLACE TRIM WITH IN-KIND MATERIAL (SAME THICKNESS AND WIDTH, ROUGH SAWN).
- (4) REMOVE AND REPLACE FASCIA BOARDS, FULL LENGTH ON ALL SIDES, WITH IN-KIND MATERIAL (SAME THICKNESS AND WIDTH, ROUGH SAWN).
- LOG FACE APPEARS TO BE SHOWING SIGNS OF DETERIORATION. REPLACE (5) MINIMUM OF 35 LINEAR FEET, IN TOTAL. FOR LOG FACES ON 4, 5, AND 7 ON THE NORTH ELEVATION. LOOK FOR FULL DETERIORATION EXTENT. PATCH/REPAIR AS NECESSARY AND MATCH EXISTING PROFILES.

LOG FACE APPEARS TO BE SHOWING SIGNS OF DETERIORATION. REPLACE 6 MINIMUM OF 100 LINEAR FEET, IN TOTAL. FOR LOG FACES ON 2, 3, 6, AND 7 ON THE EAST AND SOUTH ELEVATION. LOOK FOR FULL DETERIORATION EXTENT. PATCH/REPAIR AS NECESSARY AND MATCH EXISTING PROFILES.

- $\langle 7 \rangle$  NOT USED.
- LOG FACE APPEARS TO BE SHOWING SIGNS OF DETERIORATION. REPLACE MINIMUM OF 60 LINEAR FEET, IN TOTAL. FOR LOG FACES ON 3, 4, 5, AND 6 ON THE WEST ELEVATION. LOOK FOR FULL DETERIORATION EXTENT. PATCH/REPAIR AS NECESSARY AND MATCH EXISTING PROFILES

DESIGNED:	SUB SHEET NO.
TROHKIMOINE	
TECH. REVIEW:	Δh
HOLLING	
DATE: 08.24.2022	

TITLE OF SHEET STORE BUILDING ELEVATIONS

PKG. NO.	SHEET
	6
	of <u>8</u>

DRAWING NO.

CHIEF PLENTY COUPS STATE PARK

